
Transportation and Economic Corridors Permit

Request for Development Permit - Within Highway Right of Way in Proximity of a Provincial Highway - Approved

Permit Number:	2023-0008403	Highway(s):	2				
Issued to (Permittee):	McElhanney Ltd. For: Town of Peace River coloughlin@mcelhanney.com/ athomas@peaceriver.ca						
Legal Land Location:	QS-SW SEC-31 TWP-083 RGE-21 MER-5	Municipality:	Peace River				
Approved By:	Mary Crowley	Issuing Office:	Peace Region / Peace River				
Issued Date:	2023-04-14 13:13:32						
Description of Development:	Roadside Development permit for work adjacent to Old Highway 2/Highway 2 offramp at 99 Avenue West in Peace River, Ab. Work will include trail development, culvert install, two (2) new crosswalks (Old Highway 2 & 99 Ave W), added signage including RRFB at Old Highway 2 crosswalk. See plans for reference.						

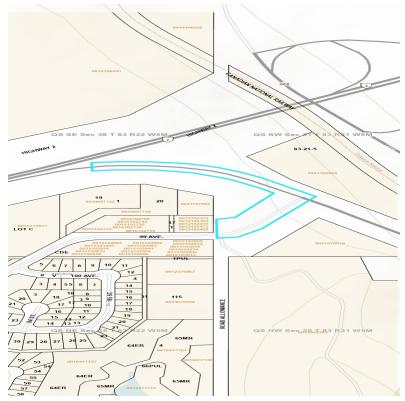

Transportation and Economic Corridors Permit No. **2023-0008403** is issued to the above named Permittee under authority of Section 14 of the *Highways Development and Protection Act* (the Act) authorizing the development(s) listed herein, and a further application is required for any changes or additions.

The approved site plan forms a part of this permit and any changes to the approved site plan will require an amendment or a new permit application.

This permit is subject to the following terms and conditions, which should be carefully reviewed:

- 1. This permit is subject to the provisions of Section 11-19 inclusive of the Highways Development and Protection Act (Chapter H-8.5 2004), amendments thereto, and Highways Development and Protection Regulation (Alberta Regulation 326/2009) and amendments thereto.
- 2. This permit is issued subject to any other municipal, provincial, or federal approvals that may be required. Issuance of a permit by Transportation and Economic Corridors does not guarantee the permittee will be able to obtain other required approvals and does not excuse violation of any regulation, bylaw, or Act that may affect the proposed development.
- 3. All works authorized by this permit shall be constructed, altered, maintained or operated at the sole expense of the Permittee.

- 4. In consideration of the permit issued in respect to this development, the Permittee shall indemnify and hold harmless Transportation and Economic Corridors, its employees and agents from any and all claims, demands, actions and costs whatsoever that may arise, directly or indirectly from anything done or omitted to be done in the construction, maintenance, alteration or operation of the works authorized.
- 5. The Permittee shall conform to the approved site plan. Failure to conform to the approved site plan without an approved amendment may result in enforcement measures as laid out in the Act
- 6. The Permittee is responsible for the ongoing maintenance and operation of all infrastructure related to the proposed work.
- 7. Durable markings must be used for the "zebra" crossing.
- 8. All disturbed areas adjacent to the highway surface must be reclaimed and reseeded in an acceptable manner. Please refer to Design Bulletin #25/2005 for the appropriate seed mix. The holder of this permit must ensure that all equipment is regularly cleaned off in order to prevent the spread of all invasive plant species that are listed in the Alberta Weed Control Act. The Permittee is responsible for any weed control in the disturbed area for a period of one year following completion of the topsoil and seeding.
- 9. The Permittee or their contractor shall contact the Maintenance Contract Inspector (MCI) Erwin Kurz at 780-618-6015:
- a. at least two (2) full working days prior to commencing work on Transportation rights-of-way to review signing and safety; and
- b. at least two (2) full working days prior to completion of construction to inspect site clean-up and restoration of disturbed areas.
- 10. A detailed Traffic Accommodation Strategy (TAS) must be provided to Transportation and Economic Corridors for review and acceptance a minimum of ten (10) business days prior to commencing work. The requirements of the TAS can be found in the most current version of the department manual entitled Traffic Accommodation in Work Zones. The Permittee will be responsible for providing any necessary measures to safely accommodate traffic through the work area and Permittee shall monitor the traffic control measures to ensure that the traffic accommodation strategy (TAS) is performing as intended and adjustments to the TAS may be necessary to address unanticipated situations. If field adjustments to this are made during this project, please submit a copy of the amended TAS for review and acceptance at your earliest convenience. You must remove and/or cover all signs when work is not in progress. Transportation will not supply signs.
- 11. Transportation and Economic Corridors is under no obligation to reissue a permit if the development is not commenced before expiry of this permit
- 12. All damages to any highways and/ or highway right of ways which may occur resulting from operations under this permit shall be immediately rectified by the Permittee. No equipment or materials shall be stored on the shoulder, sideslope or backslope of the highway. Equipment accessing the right-of-way will access only from existing high grade approaches. Where there is no permanent access the Permittee shall use rig mats to access the site from the shoulder of the highway
- 13. This permit approves only the development contained herein, and a further application is required for any changes or additions

Failure to comply with the terms and conditions of this permit is an offense pursuant to Section 35 of the

Highways Development and Protection Regulation (the Regulation), and may result in enforcement or penalties as described in Section 55 of the Act and Section 35-36 of the Regulation.

This permit is valid for a period of **two years from the date of issuance**. If the works authorized by this permit have not commenced within this timeframe, the permit expires and the Permittee must submit a request for an extension, or reapply for a new permit, if they wish to proceed. Transportation and Economic Corridors is under no obligation to reissue a permit if the development is not commenced before expiry of this permit.

Please contact Transportation and Economic Corridors through <u>RPATH application</u> if you have any questions, updates, additions, or require additional information.



Issued by **Mary Crowley**, , on **2023-04-14 13:13:32** on behalf of the Minister of Transportation and Economic Corridors pursuant to *Ministerial Order 52/20 – Department of Transportation and Economic Corridors Delegation of Authority*



ISSUED FOR TENDER REVIEW FEBRUARY 28, 2023

99 AVENUE WEST TRAIL DEVELOPMENT

TOWN OF PEACE RIVER, ALBERTA





UTILITY LOCATES

NO RESPONSIBILITY IS IMPLIED OR ASSUMED BY THE ENGINEER/LANDSCAPE ARCHITECT AS TO THE LOCATION AND ELEVATION OF ANY UTILITY. THE CONTRACTOR IS RESPONSIBLE FOR DETERMINING THE EXISTENCE AND LOCATION OF ALL UTILITIES THAT MAY BE IMPACTED AND MUST CONTACT THE VARIOUS UTILITY COMPANIES FOR THIS SITE PRIOR TO COMMENCEMENT OF ANY OPERATIONS. PROVIDE ENGINEER/LANDSCAPE ARCHITECT WITH COPY OF ALL LOCATE REPORTS.

DRAWING INDEX

COVER SHEET KEY PLAN & DRAWING INDEX SITE PREPARATION PLAN GRADING & LAYOUT PLAN LANDSCAPE DETAILS

TOWN OF PEACE RIVER 9911 100 Street, Peace River, AB, T8S 1S4

99 AVE WEST TRAIL DEVELOPMENT Key Plan & Drawing Index

L001

9							
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28, 12	02	2023-01-18	ISSUED FOR TENDER REVIEW	JM	СО	CA	EMPLOYEES OR AGENTS, WITHOUT McELHANNEY'S PRIOR WRITTEN CONSENT.
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ATE	Rev	Date	Description	Drawn	Design	App'd	PLAN. PRIOR TO CONSTRUCTION CONTRACTOR SHALL EXPOSE LOCATIONS OF ALL EXISTING FACILITIES BY HAND DIGGING OR HYDROVAC AND ADVISE THE ENGINEER OF POTENTIAL CONFLICTS.

Unit 201 13455 114 Avenue NW Edmonton AB Canada T5M 2E2 Tel 780 809 3200

PEACE RIVER, AB

2131-00611-05

Drawing No.

EXISTING TRAIL LIMIT OF DISTURBANCE EXISTING RIP RAP DRAINAGE DITCH ASPHALT TRAIL EXISTING GRAVEL PAD TO BE REMOVED BY ALBERTA TRANSPORTATION AT A LATER DATE EXISTING CULVERT 99th AVENUE WEST 99th AVE WEST TRAIL - SITE PREPARATION PLAN

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LEGEND

TOPSOIL REMOVAL RIP RAP REMOVAL PROPERTY LINE EXISTING MAJOR CONTOUR - 1m EXISTING MINOR CONTOUR - 0.5m LIMIT OF DISTURBANCE EXISTING DRAINAGE SWALE **EXISTING CULVERT** EXISTING GUARD RAIL **EXISTING JERSEY BARRIERS** EXISTING FENCE EDGE OF EXISTING GRAVEL PAD

SCALE 1:300

00611							
jects∖							THIS DRAWING AND DESIGN IS THE PROPERTY OF MCELHANNEY AND SHALL NOT BE USED, REUSED OR REPRODUCED WITHOUT THE CONSENT OF MCELHANNEY. MCELHANNEY WILL NOT BE HELD RESPONSIBLE FOR
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McElhanney

Unit 201 13455 114 Avenue NW Edmonton AB Canada T5M 2E2 Tel 780 809 3200

Approved Sealed

9911 100 Street, Peace River, AB, T8S 1S4

PEACE RIVER, AB


TOWN OF PEACE RIVER


99 AVE WEST TRAIL DEVELOPMENT Site Preparation Plan

L101

2131-00611-05

Drawing No.

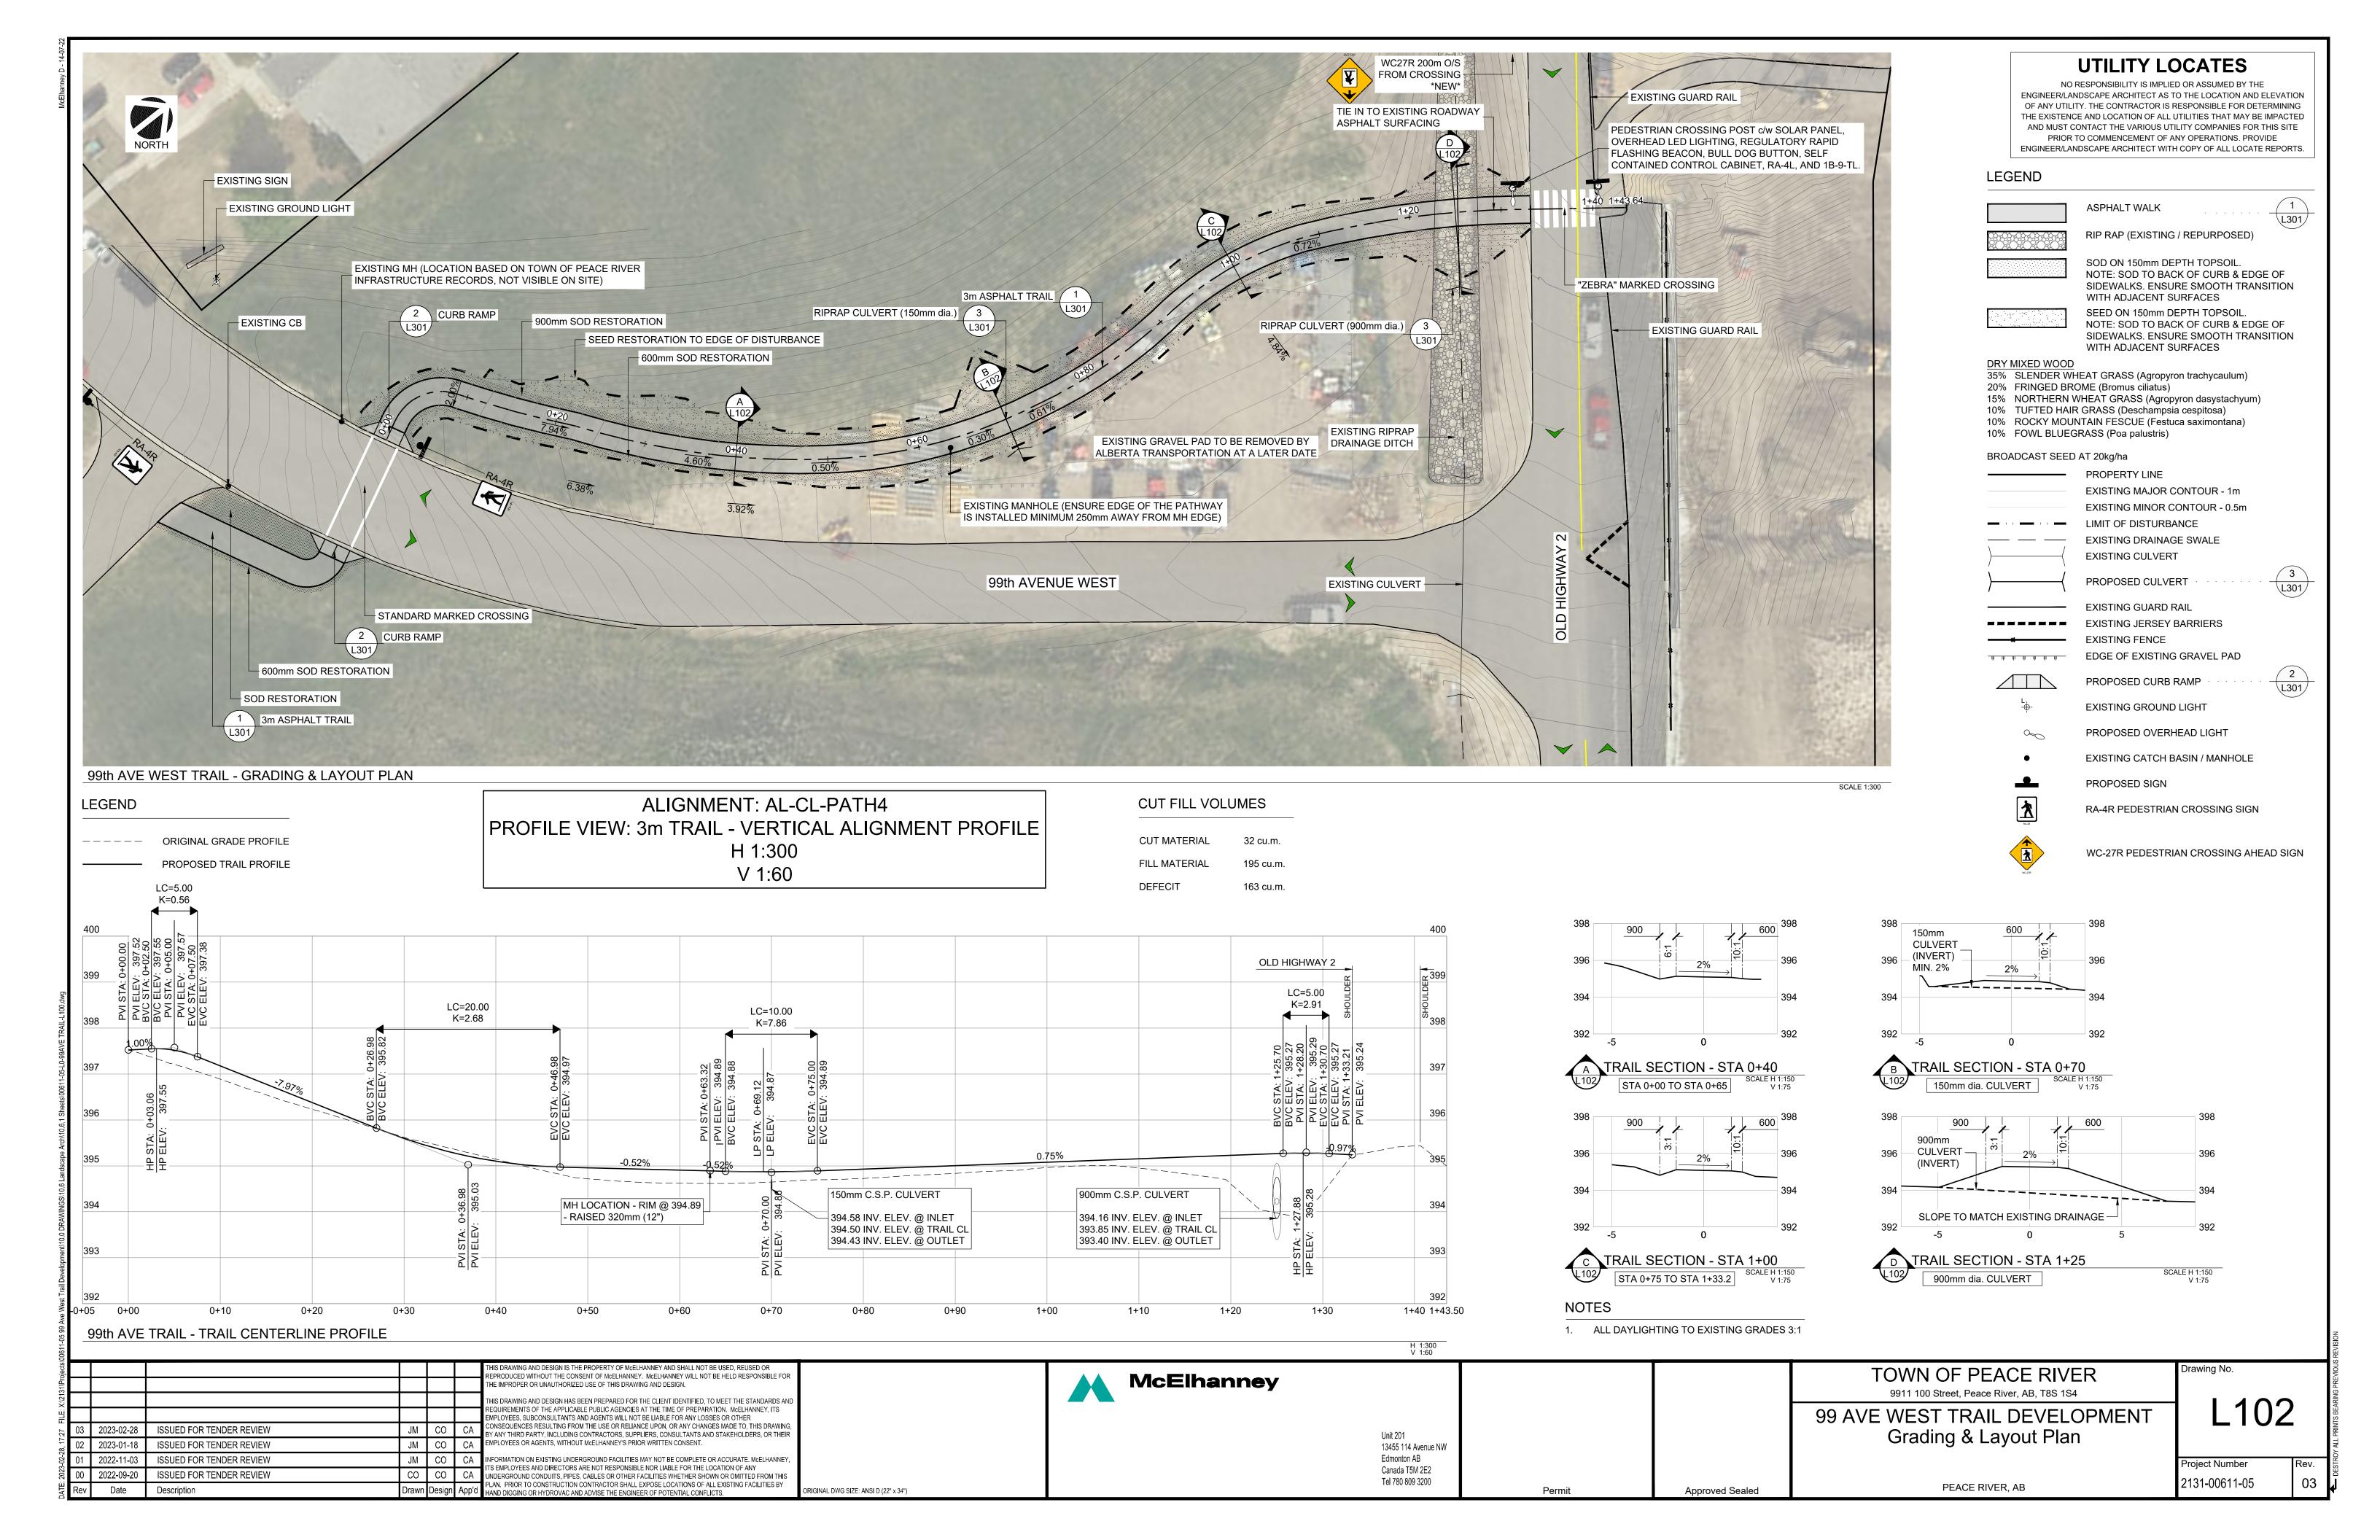

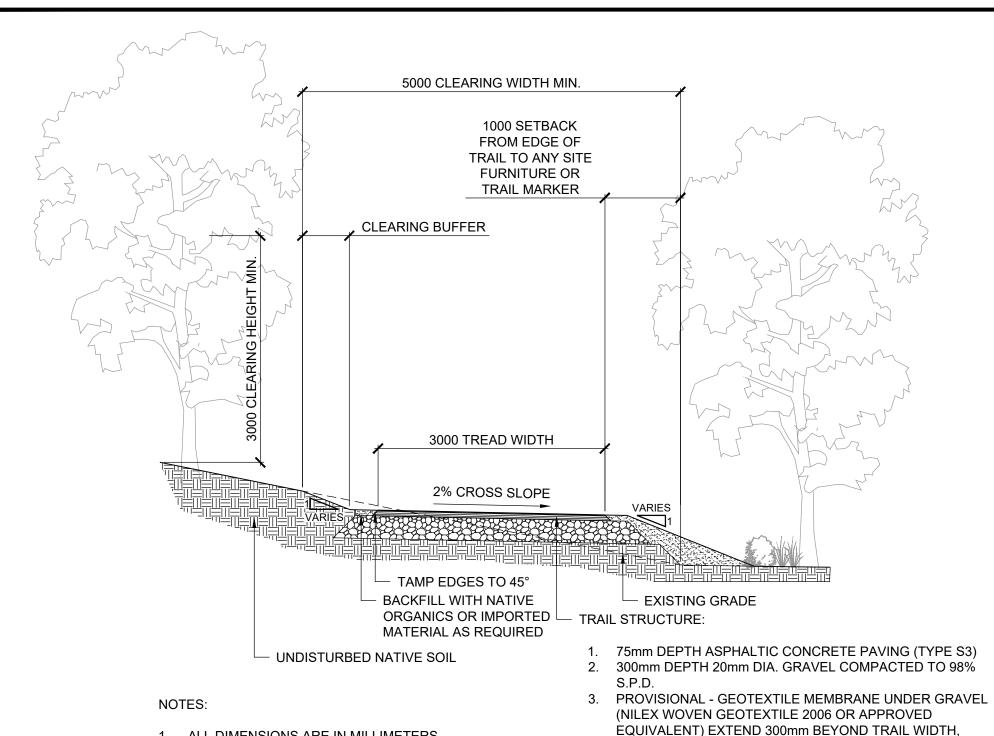

CONTINUOUS.

TO 100% S.P.D.

RRFB (REGULATORY RAPID

PER MANUFACTURER

SPECIFICATIONS.

FLASHING BEACON) AND OTHER

EQUIPMENT TO BE INSTALLED AS

4. NATIVE SUBGRADE SCARIFIED AND COMPACTED TO 100%

PLACED OVER APPROVED SUBGRADE AND COMPACTED

S.P.D. - FREE OF TOPSOIL, ROOTS AND/OR DEBRIS

A) COMMON FILL - CLEAN CLAY OR GRANULAR MATERIAL

- 1. ALL DIMENSIONS ARE IN MILLIMETERS.
- 2. SUBGRADE PREPARATION TO BE DETERMINED ACCORDING TO SPECIFIC SOIL CONDITIONS AND APPROVED BY OWNER'S REPRESENTATIVE OR

SOLAR PANEL

OVERHEAD LED LIGHTING

5 POST TOP POLE

SELF CONTAINED CONTROL CABINET

RA-4R / RA-4L - BLACK, WHITE, 750mm X 600mm

FLASHING BEACON) - 1B-9-TR / 1B-9-TL - BLACK,

WHITE, 750mm X 600mm

- BULLDOG PUSH BUTTON

6 POLE BREAKAWAY BASE ASSEMBLY

RRFB (REGULATORY RAPID


CONSULTANT PRIOR TO CONSTRUCTION. 3. BALANCE CUT & FILL ACROSS SECTION.

√ 3m ASPHALT TRAIL

F.O.C. SAW CUT CONTROL └─ 150mm CURB JOINTS 5mm WIDE 10mm 250mm GUTTER PLAN VIEW DEEP @ 150mm O.C.

B.O.W. _____ F.O.C.

ELEVATION

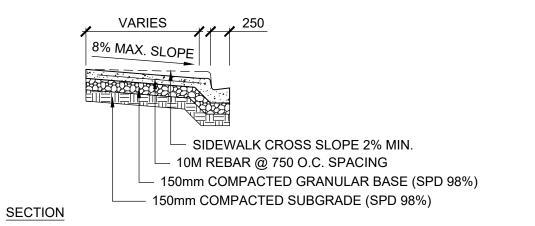

NOTES:

- 1. ALL DIMENSIONS ARE IN MILLIMETERS.
- 2. 32MPa CONCRETE.
- 3. B.O.W. REFERS TO BACK OF WALK.

2 CURB RAMP

4. F.O.C. REFERS TO FRONT OF CURB.

SCALE H 1:50



FURNITURE SCHEDULE

RRFB SIGNAGE AND LIGHTING

Qty	Description	Manufacturer	Model # / Type	Color / Materials	Mount
2	RRFB Pedestrian Crossing Kit (Solar)	Carmanah	Single, Black, Standard Pushbutton-Yellow, Solar, Integrated Solar Engine-Black, Overhead LED Light	Black/Yellow/Black	Pole Mounted
2	Pedestrian Sign (Right)	ATS Traffic	RA-4R	Aluminum, Black, White, 750mm x 600mm	Pole Mounted
2	Pedestrian Sign (Left)	ATS Traffic	RA-4L	Aluminum, Black, White, 750mm x 600mm	Pole Mounted
1	Right Angle Arrow Tab	ATS Traffic	1B-9-TR	Aluminum, Black, White, 300mm x 450mm	Pole Mounted
1	Left Angle Arrow Tab	ATS Traffic	1B-9-TR	Aluminum, Black, White, 300mm x 450mm	Pole Mounted
1	Pedestrians Ahead Sign (Right)	ATS Traffic	WC-27R	Aluminum, Yellow, Black, White, 750mm x 750mm	Pole Mounted
2	Caltran Pole	ATS Traffic	Type 1A	Aluminium, 5" Base, 16" Height	Concrete Pile c/ Breakaway Boli
3	Telespar Post Square	ATS Traffic	Standard	Galvanized Steel, 1.75" width, 6' Height	Soil Anchor
1	Culvert	Armtec	800mm dia C.S.P, 16 ga. c/w Flared Ends	Corrugated Steel	Ground

DESIGN LOADS FROM LIGHT POLE 4.9m (16') POLE 6.1m (20') POLE 3.2 (1") THICK x 127 (5") LONG PIPE SEAL 3 G TENON (SEE DETAIL)-11ø (语") HOLE FOR GALVANIZING OPPOSITE THE SEAM WELD 96 (3 ¾") A/F- REFER TO ROAD AND WALKWAY LIGHTING CONSTRUCTION & MATERIAL STANDARDS FOR FURTHER INFORMATION. OF 0.28m² @ 160 km/h WIND SPEED (+1.3 GUST FACTOR) 254 (10") |◀ 181 (7 1") → — 254ø (10") BCD 4-32 x 54 (1 ¼" x 2") DIA. ANCHOR BOLT HOLES BASE PLATE REFER TO BASE PLATE DETAIL ABOVE AND ON DWG. E3.11 Dimensions in Metric Transportation and Streets 4.9m (16') & 6.1m (20') POST TOP POLES - ALM Originals signed by:
cale: Checked By:
N.T.S. DSM Old Drawing # 8570M ______

5 POST TOP POLES SCALE H 1:50


RIP RAP SPECIFICATIONS:

CLASS 1

- 1. 100% OF TOTAL VOLUME OF STONES WITH INDIVIDUAL SIZE LESS THAN 450mm.
- 2. NOT LESS THAN 50% OF TOTAL VOLUME OF STONES WITH
- INDIVIDUAL VOLUME LESS THAN 350mm. 3. REMAINING PERCENTAGE OF TOTAL VOLUME TO HAVE UNIFORM
- DISTRIBUTION OF STONES BETWEEN 100mm AND 350mm. 4. THICKNESS OF RIP RAP = 500mm.
- 5. SUPPLY ROCK SPALLS OR COBBLES TO FILL OPEN JOINTS.

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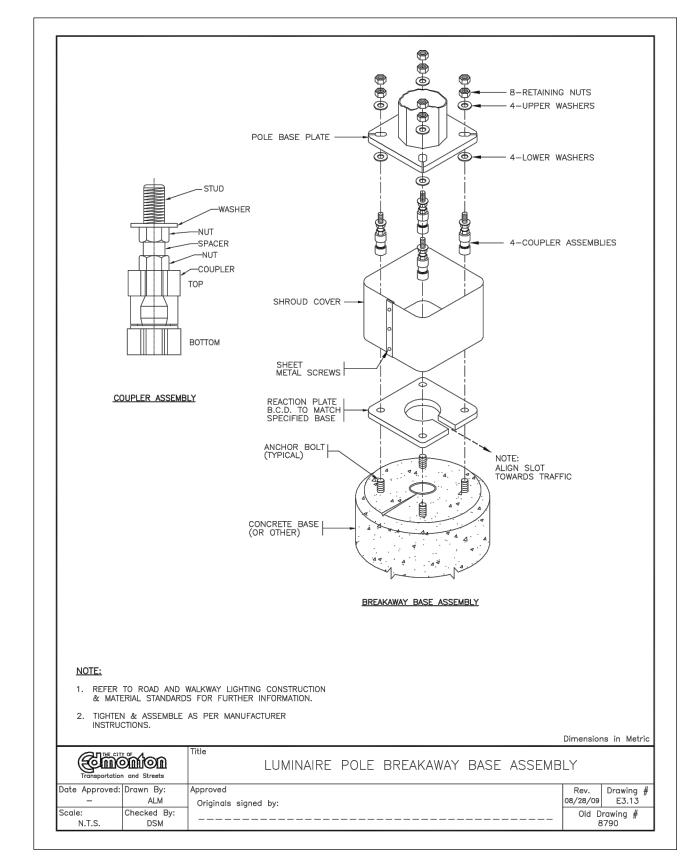


NOTES:

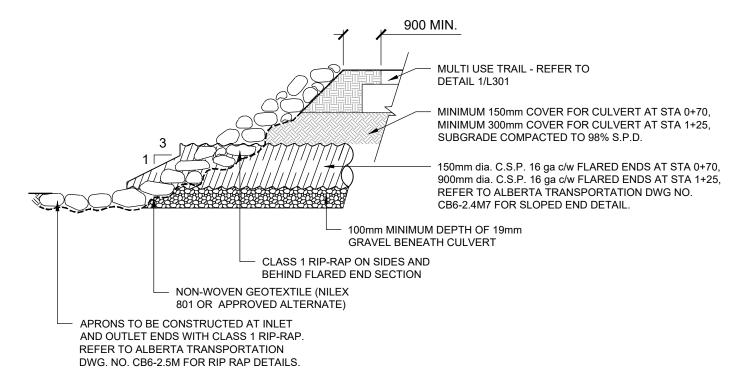- 1. ROCKS AND BOULDERS SHALL BE SELECTED AS NEARLY CUBICAL IN FORM AS PRACTICABLE.
- 2. THE LARGER STONES BEING USED IN THE BOTTOM COURSES AND THE SMALLER STONES AT THE TOP.
- 3. THEY SHALL BE LAID IN CLOSE CONTACT SO AS THE BREAK JOINTS AND IN SUCH MANNER THAT THE WEIGHT OF THE STONES IS CARRIED BY THE EARTH AND NOT BY THE ADJACENT STONES.

RIPRAP CULVERT

SCALE H - NTS



YPOLE BREAKAWAY BASE ASSEMBLY

9911 100 Street, Peace River, AB, T8S 1S4

TOWN OF PEACE RIVER

SCALE H 1:50

Drawing No.

L301

03

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McElhanney

Unit 201 13455 114 Avenue NW Edmonton AB Canada T5M 2E2

Tel 780 809 3200

Approved Sealed

PEACE RIVER, AB

99 AVE WEST TRAIL DEVELOPMENT

Landscape Details

Project Number 2131-00611-05

Illumination of Isolated Rural Intersections LIGHTING WARRANT SPREADSHEET

This spreadsheet is to be used in conjunction with Illumination of Isolated Rural Intersections, Transportation Association of Canada, February 2001.

Please enter information in the cells with yellow background

INTERSECTION CHARACTERISTICS	
Old Highway 2 (Hwy 2 Off-Ramp)	Main Road
99 Avenue West	Minor Road
Peace River, AB	City/Town

Date Other

April 10, 2023 2022 Traffic Data

GEOMETRIC FACTORS						
	Value	Rating	Weight	Comments	Check	Score
Channelization Rating	Descriptive	0		Refer to Table 1(A) to determine rating value	OK	
Presence of raised channelization? (Y/N)	n				OK	
Highest operating speed on raised, channelized approach (km/h)	0		5		OK	
Channelization Factor					ОК	0
Approach Sight Distance on most constrained approach (%)	80	1	10	Relative to the recommended minimum sight distance	OK	10
Posted Speed limit (in 10's of km/h)	50				ОК	
Radius of Horizontal Curve (m)	300			Enter "T" for tangent (no horizontal curve at the intersection)	OK	
Posted Speed Category =		0				
Posted Speed Category =		0				
Posted Speed Category =		0				
Posted Speed Category =	D	3				
Horizontal Curvature Factor		3	5		ОК	15
Angle of Intersection (10's of Degrees)	90	0	5		ОК	0
Downhill Approach Grade (x.x%)	9.0	4	3	Rounded to nearest tenth of a percent	OK	12
Number of Intersection Legs	3	1	3	Number of legs = 3 or more	ОК	3
				Geometric Facto	ors Subtotal	40

OPERATIONAL FACTORS						
Is the intersection signalized ? (Y/ N)	n			Calculate the Signalization Warrant Factor		
AADT on Major Road (2-way) AADT on Minor Road (2-way) Signalization Warrant	940 300 Descriptive	0 0 0	10 20 30	Either Use the two AADT inputs OR the Descriptive Signalization Warrant (Unused values should be set to Zero) Refer to Table 1(B) for description and rating values for signalization warrant.	OK OK	0 0 0
Night-Time Hourly Pedestrian Volume	5	1	10	Refer to Table 1(B), note #2, to account for children and seniors	OK	10
Intersecting Roadway Classification	Descriptive	0	5	Refer to Table 1(B) for ratings.	OK	0
Operating Speed or Posted Speed on Major Road (km/h)	50	0	5	Refer to Table 1(B), note #3	OK	0
Operating Speed on Minor Road (km/h)	30	0	5	Refer to Table 1(B), note #3	ОК	0
				Operational Factors	Subtotal	10

ENVIRONMENTAL FACTOR						
Lighted Developments within 150 m radius of intersection	1	1	5	Maximum of 4 quadrants	OK	5
					Environmental Factor Subtotal	5

COLLISION HISTORY						
Average Annual night-time collision frequency due to inadequate lighting (collisions/yr, rounded to nearest whole #)	0.0	0	0	Enter either the annual frequency (See Table 1(C), note #4)	ОК	0
OR Collision Rate over last 3 years, due to inadequate lighting (/MEV)	0	0	0	OR the number of collisions / MEV (Unused values should be set to Zero)	OK	0
Is the average ratio of all night to day collisions >= 1.5 (Y/N)	n	0			OK Oł	<
				Collision His	tory Subtotal	0

Check Intersection Signalization: Intersection is not Signalized

LIGHTING IS NOT WARRANTED

SUMMARY	
Geometric Factors Subtotal	40
Operational Factor Subtotal	10
Environmental Factor Subtotal	5
Collision History Subtotal	0
TOTAL POINTS	55